

Roof ties to match existing on 25x38mm s/w/ battens
on concry 150 vapour permeable roofing felt on 150x150mm sw rafters
bearing on 75x100mm s/w wall plates at 450mm c/c and 1x50x100mm sw bearer
bolted to wall.
Ceiling joists to be 50x150mm at 450 c/c fixed to rafters and bearing on 50x100mm
sw hangers.
Plasterboard and skim finished.
To all triangular roof piers provide 270mm of fibre glass quilt
170mm laid between joists with 100mm laid over top at right angles)
Provide ventilation to roof space using REDLAND Joist Vents
Over Fascia vents fitted to manufacturers instructions.
Provide high level roof vent if necessary.
Provide 1x30x900mm long mild steel straps fixed over wall plate
and fixed to wall at max 2m c/c.
Provide 15mm ply wood fascia board and soffit at eaves to receive
100mm dia. UPVC half round gutter draining to 68mm dia. Rsp.
To form full valleys provide 25x175mm code for lead lined valley boards
to support feet of rafters.

All other roofs:
Roof tiles on battens on felt on rafters as above but nailed at top to 38x175mm timber ridgeboard. Ceiling joists fixed as above.
All insulation, ventilation and soffit details as above.

Interlocking roof tiles suitable for the pitch on 38x50mm treated battens on layer of breather membrane e.g. Tyvek Perma, draped over rafters with a min 25mm air gap above the insulation. The membrane will allow moisture to drain into the gutter. 150mm Kingspan Thermo Pitch P110, between 200mmx30mm SC3 Grade 5 rafters @ 400mm ctrs, for 4,000mm span.

The roof will be plated on the underside with 12.5mm thick Douglas Fir Ply nailed with 49mm dia x 75mm long nails at 75mm centres to the underside of the rafters. The roof will be finished internally with a 9.5mm ply & skim. The roof will have a 150mm deep 4 lead flashing and apron flashing at its junction with the wall. A cavity tray will be used with the flashing to prevent the ingress of water. The top ends of the rafters will be nailed to a 38x200mm timber ridgeboard. The wallplate will be rafterbolted to the wall with 12.5mm dia rafterbolts @ 900mm str.

The eaves of the rafter will be birdsmouthed onto a 100 x 150mm ss wallplate and fixed with truss clips. The wallplate will be strapped to the wall with 30mm x5mm ms straps at 1,200mm centres. End rafters to be resin bolted @ 900mm centres into the adjacent walls to prevent shear with (a min 40mm 10mm dia resin bolts). The rafters will be doubled where trimmed around the roof lights.

All c/s pyps to be boxed in and insulated to part L. Provide an unscrawable access panel to enable full roddability.

All invert and cover levels to manholes to be agreed on site with local authority building inspector.

All s/s ways to be designed in accordance with BRE Digest 365 and to be a minimum of 5m from building.

Foundations

Concrete strip foundations: 600mm wide x200mm deep with an approx. cover of 90mm (refer to section drawing).

All internal load bearing walls built of 400mm wide concrete strip foundation.

Foundations are to be to complete satisfaction of local authority Building Inspector and are to suit site conditions.

125mm brick work outer leaf (type to match existing)
100mm full fill cavity with insulation and 100mm thermalite
blockwork inner leaf to give overall U value of 0.28 w/m²K.
Plaster and skim internally. Provide splayed weak mix concrete cavity fill
a minimum of 22.5mm below dpc level with stainless steel vertical twist walls
ties at maximum centres of 450mm vertical and 900mm horizontal (c/w)
and to be staggered at door and window openings. Stagger to be 300mm.
Ties to be in accordance with BS 1234 and to be inclined to the outer leaf.
Provide Hyload dpc, or similar approved, a minimum 150mm above external
ground level.
Install IG stainless steel lintels (type LU/S80 with cavity tray dpc's over),
or similar approved above all new door and window openings on external
walls.
Cavity to be dosed at head with supalux.
Cavity to be dosed at openings with insulated cavity doses by DAMCORE.
Use Domicore vertical dpc at all new external openings.
Provide 5x30x90mm long mild steel restraint straps fixed across 3 no.
rafters, where rafters run parallel to walls. Allow for nogging between
rafters. Provide weepholes at maximum 900mm c/c above ground level and
above cavity tray dpc's. A minimum of 3 per opening is required.

- All new fittings to have 75mm deep seal traps or resealing traps if sink is more than 3.2m from gully. Sink to be also have 38mm dia waste.
- Encase all drains under buildings in 150mm concrete.
- All foul and surface water drainage to be 100mm dia, approved type unless otherwise stated.
- Provide Lintels where drains pass through external walls.
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- All invert and cover levels to manholes to be agreed on site with local authority building inspector.
- all soakways to be designed in accordance with BRE Digest 365 and to be a minimum of 5m from building.

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Construct ground floor in 75mm sand and cement screed on 150mm concrete slab on 85mm celotex insulation on 1200 gauge visqueen damp roof membrane on a sand blinded hard core in 150mm well compacted and consolidated layers. dpm to lap dpc.

Provide 25mm of celotex to perimeter of slab and screed at external walls, to prevent cold bridge.

General
Window areas of habitable rooms are to be 1/10th the floor area and are to be provided with trickle ventilation system or facility to give total area not less than 8000mm². Window openings are to be 1/20th area.
All openings to be fully draughtproof.
All windows are to be double glazed with a 22mm gap and incorporating K glass. (u value of 1.6 w/m²k)
All Bedroom windows are to have clear minimum openings of 850mm high x 500mm wide.
Glazing to all bathroom and en suite rooms to be obscured.
Glazing to all critical areas to be fitted with toughened, thickened, or laminated kite mark safety glass.
Style of windows to be confirmed.

A self contained non maintained type interconnected smoke detection system is required in all hallways and landings.





Insert mechanical extract vents to kitchens, utility, bathroom and en suites to give minimum ventilation of:
 Kitchen - 60 litres / second.
 Utility - 30 litres / second
 Bathroom and en suites - 15 litres / second
 A minimum 3 no. air changes per hour are required to each. Vent positions agreed on site.
 (provide 15 minute overrun to bathroom and en suites).

In order to satisfy building regulations all structural timbers used must be strength graded and marked Dry or KD.


Provide energy efficient lighting

Efficiency & Locations of all new boilers to be confirmed by main contractor.
Details of central heating system to be confirmed.
Position of flue terminals to be in accordance with gas safety regs, & be installed by Corgi registered installer.
All new radiators are to be fitted with thermostatic valves & to be in strict accordance with domestic heating guide.

All electrical works to meet part P & must be installed, inspected and tested, by a person competent to do so. An appropriate BS 7671 electrical installation certificate is to be issued by person competent to do so after council is satisfied that part P has been complied with.

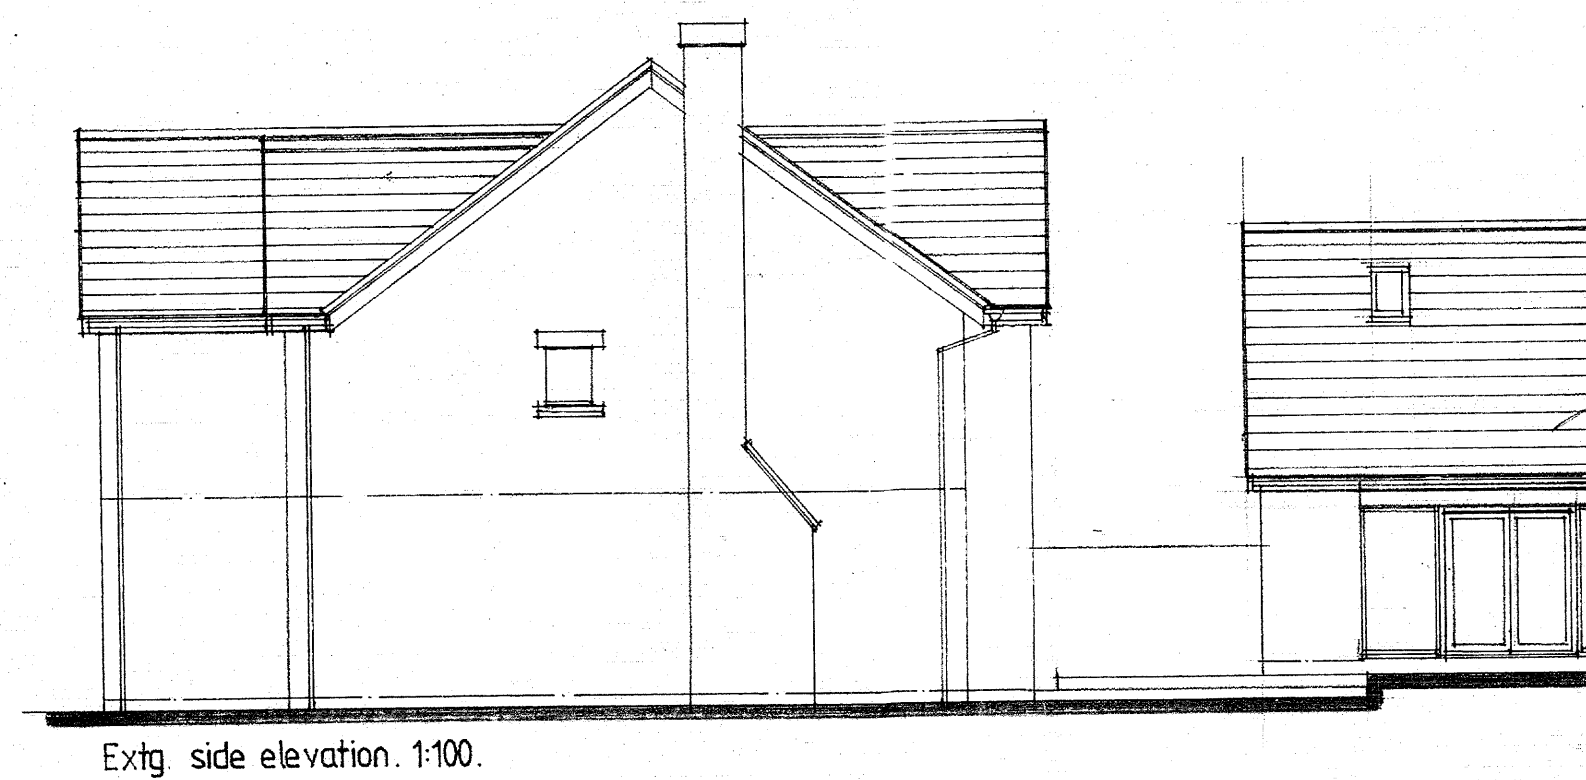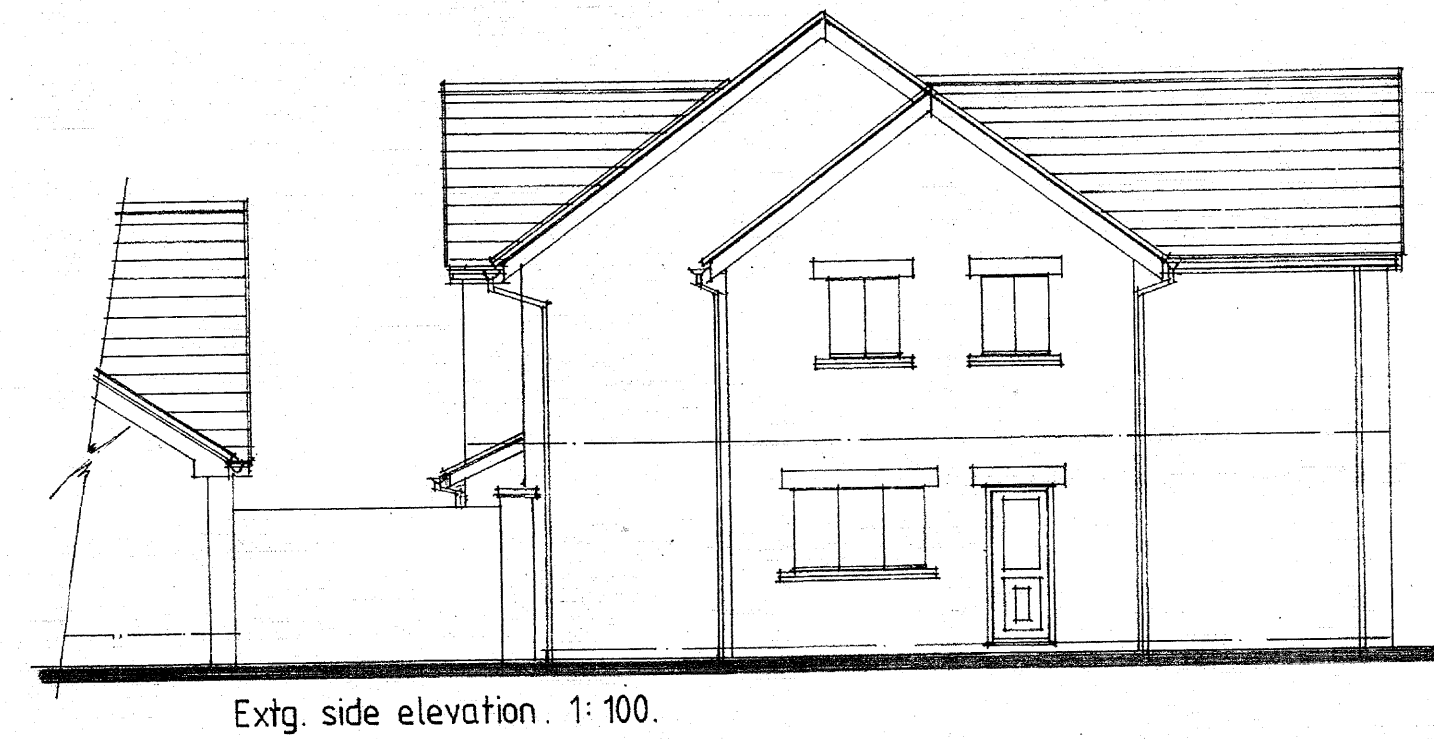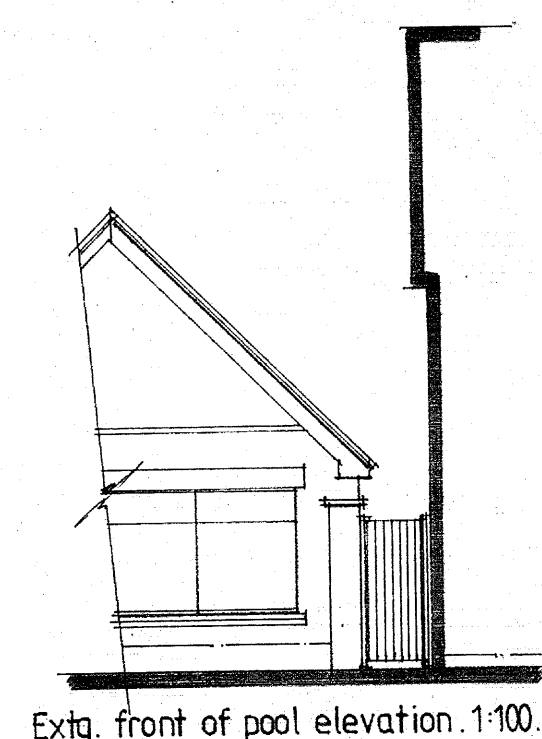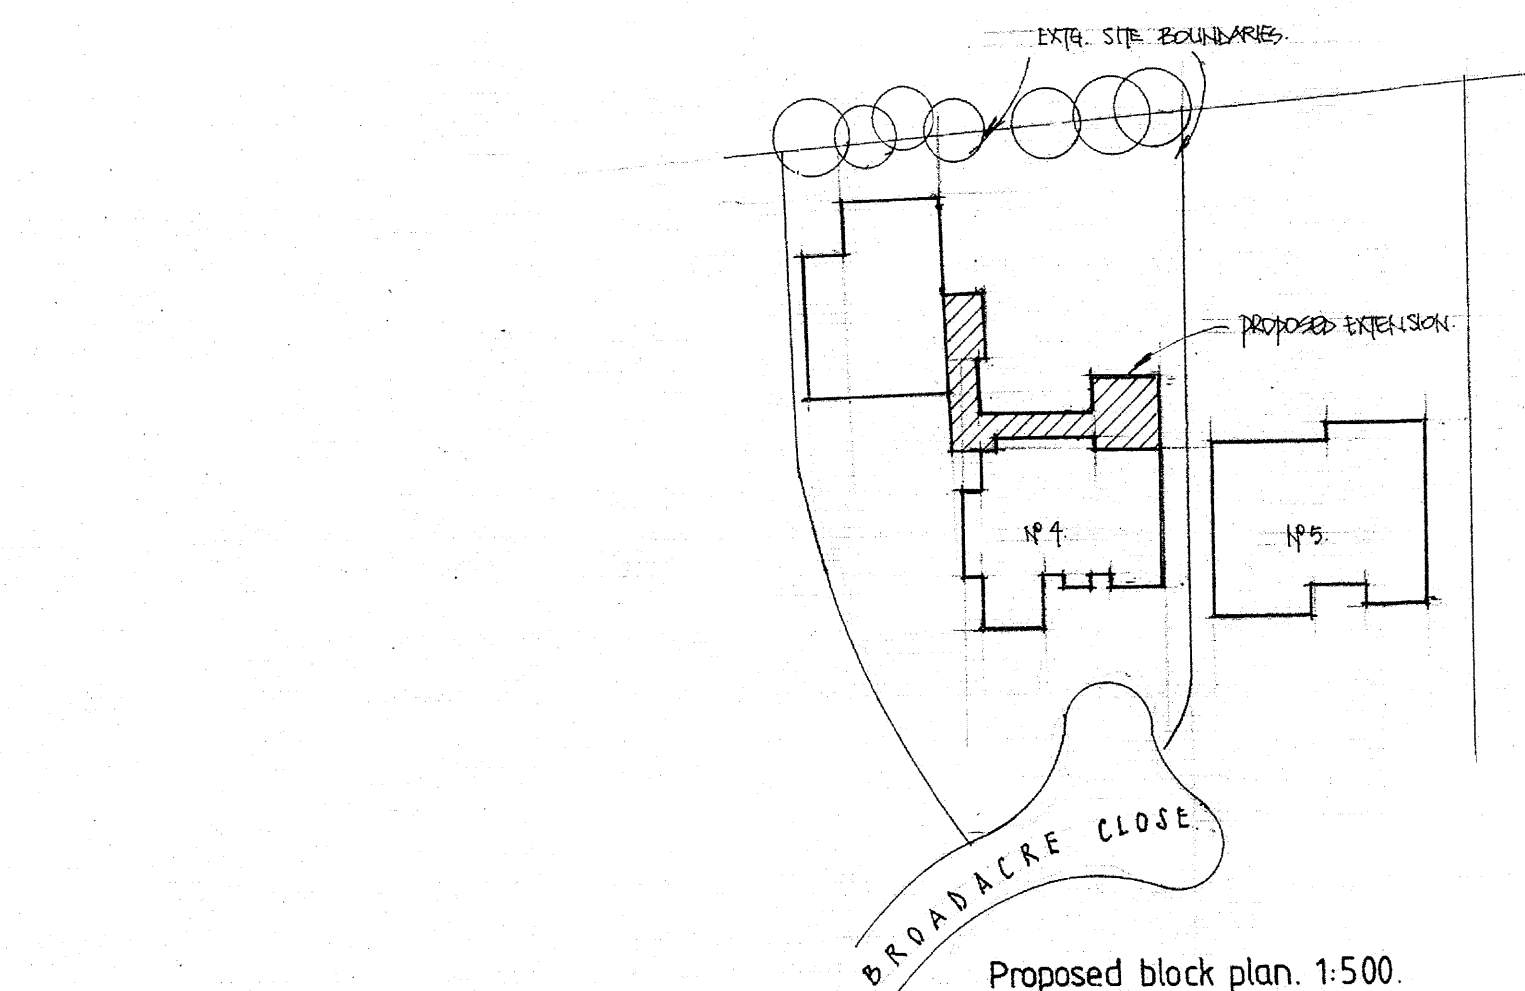

DO NOT SCALE OFF THIS DRAWING.
ALL DIMENSIONS TO BE CHECKED ON SITE.
ALL ELEMENTS OF STRUCTURE TO BE SHR
FIRE RESISTING.

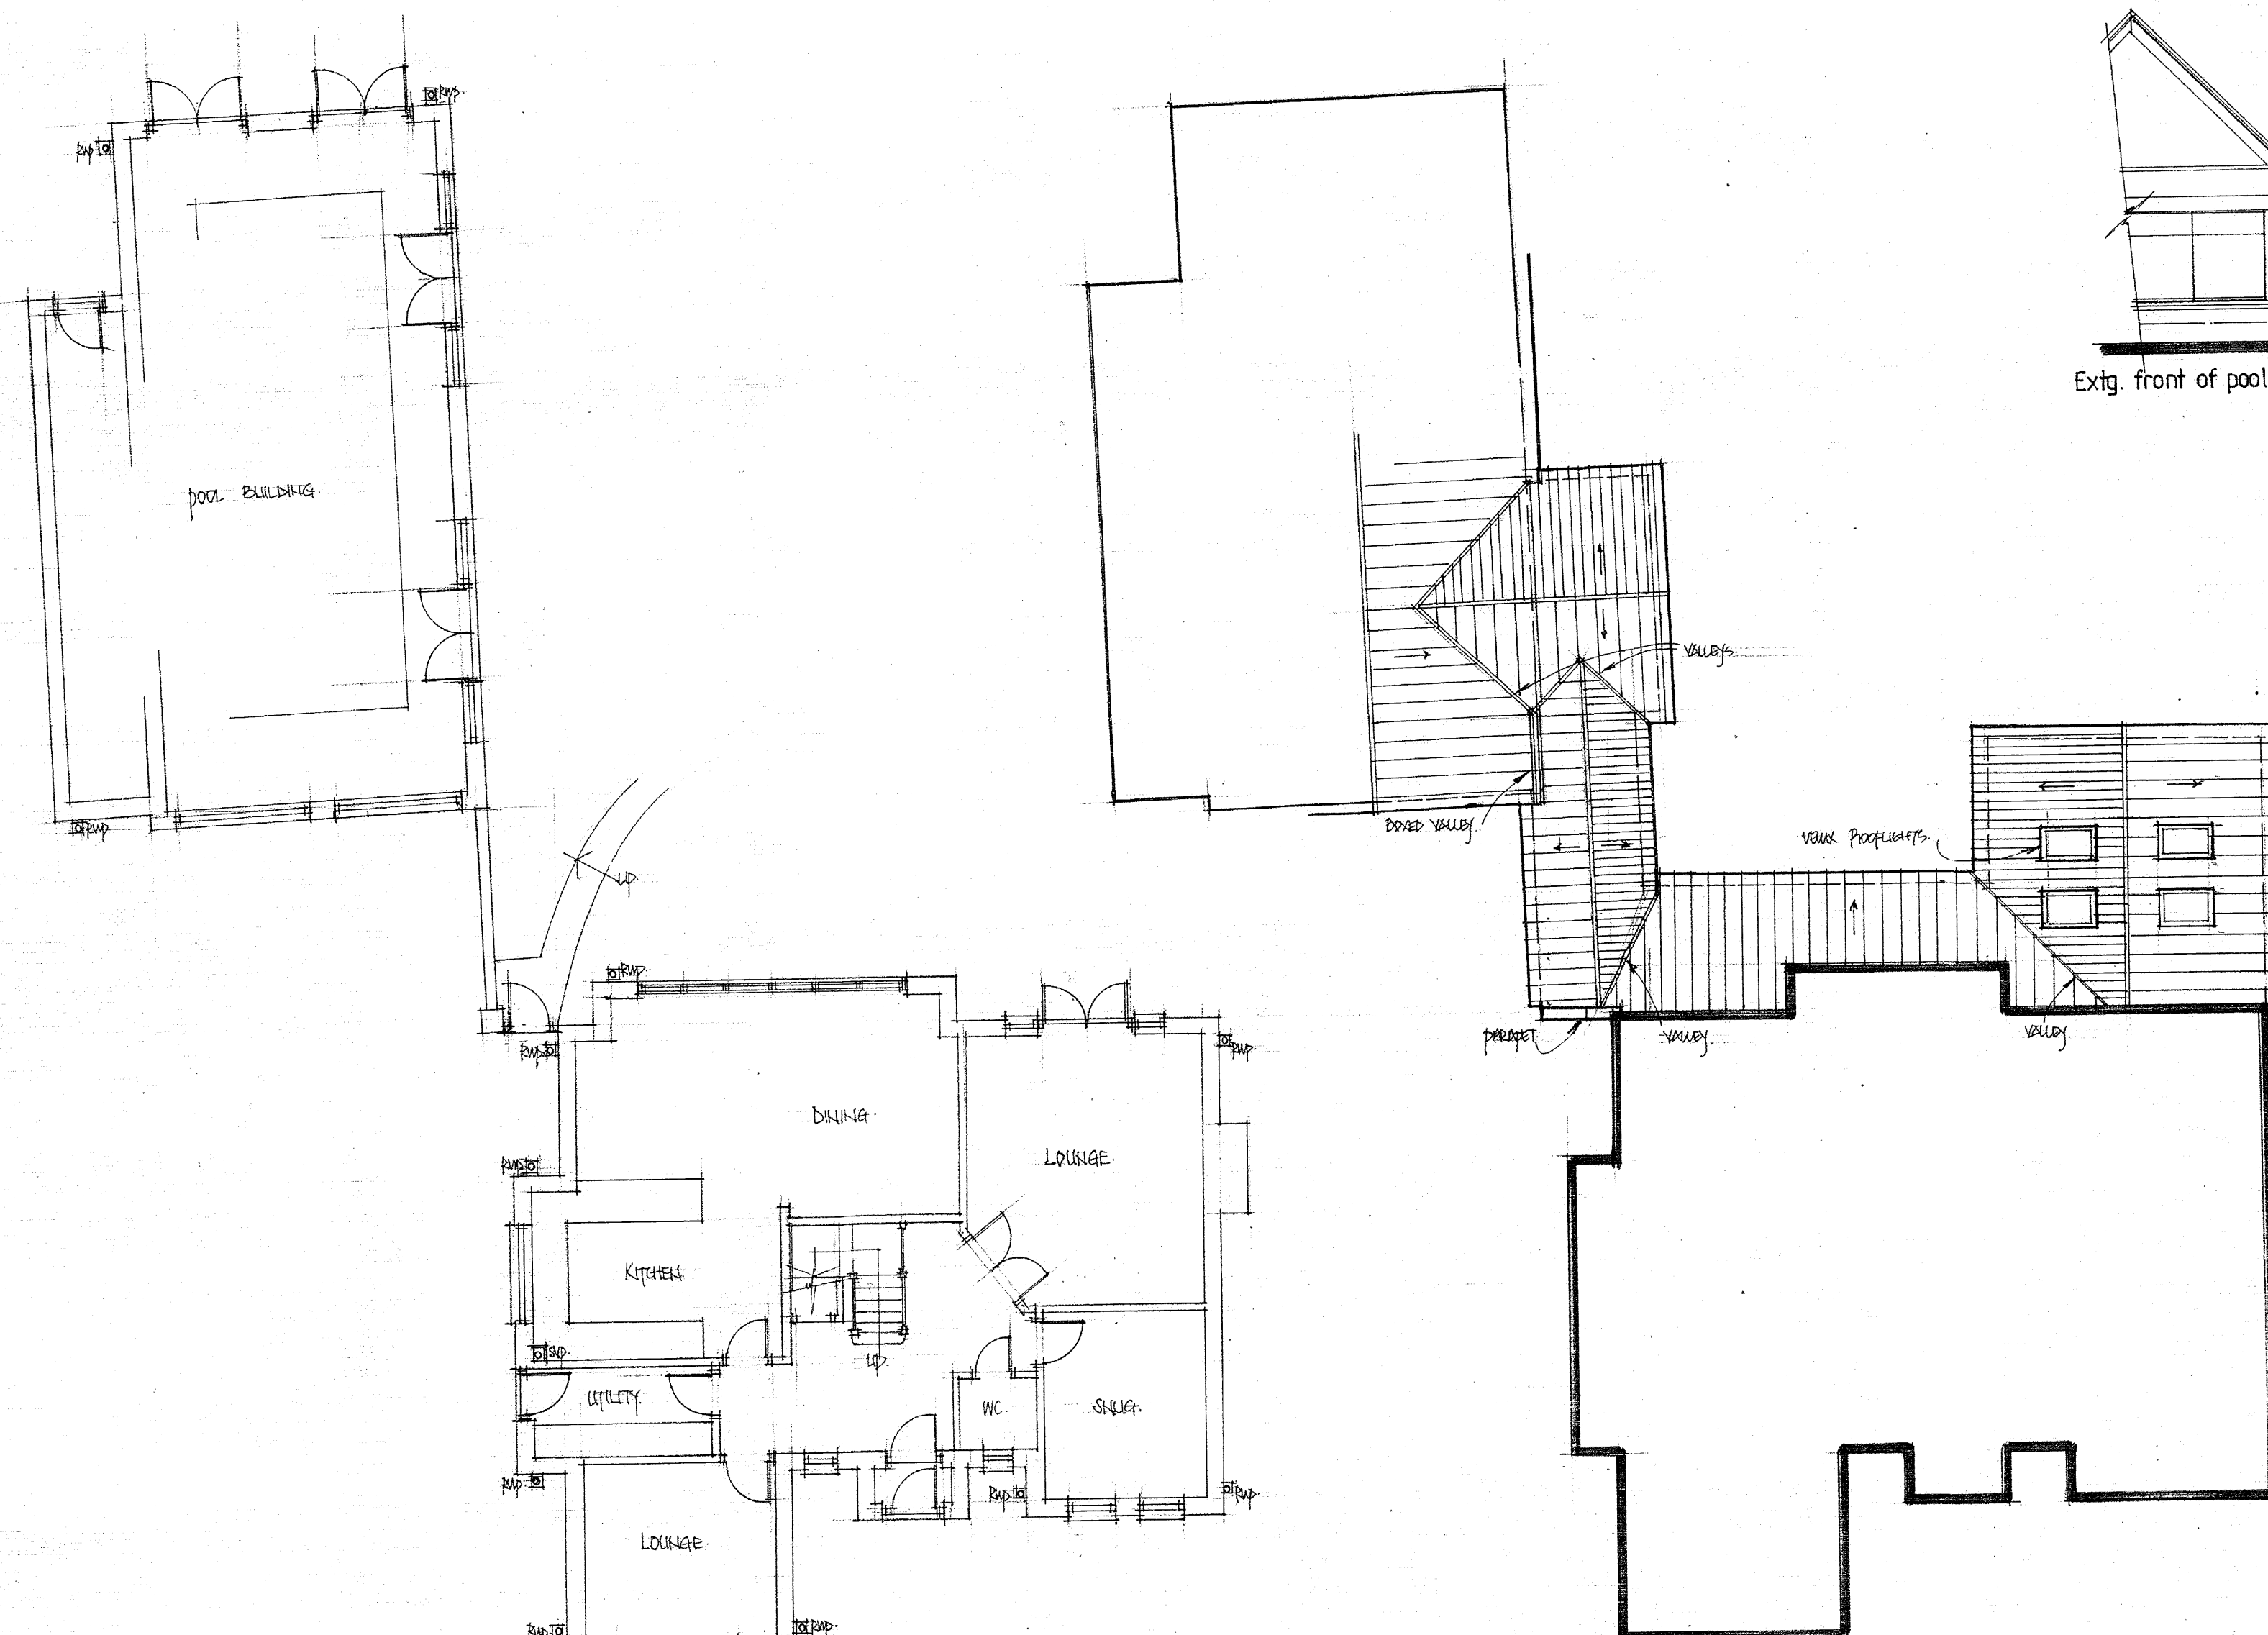

Exta. ground floor plan. 1:100.

Proposed roof plan. 1:100.

NOTES		
REVISION	AMENDMENT	DATE
CLIENT MR. P. CARNEY 4 BROADACRE CLOSE. CHILDWALL LISB. 2JW.		
DRAWING TITLE SINGLE STOREY PITCHED ROOF EXTENSIONS TO REAR INCLUDING LINK TO DETACHED POOL BUILDING, <div style="text-align: right;"> ISH 10778 28/3/15 </div>		
EXISTING PLANS & ELEVATIONS, PROPOSED BLOCK & ROOF PLANS.		
SCALE 1:50. 1:100. 1:200.	DRAWING No. <div style="text-align: center; font-size: 2em;">01.</div>	REV.
DATE MARCH' 2015.		