

- DO NOT SCALE THIS DRAWING
- Notes
- DO NOT SCALE FROM THIS DRAWING.
 - REFER TO DRG BHC2020-21 FOR STANDARD DETAILS.
 - REFER TO MANHOLE SCHEDULE FOR MANHOLE AND INVERT LEVEL INFORMATION.
 - REFER TO BHC1500 AND BHC1510 FOR EXISTING DRAINAGE AND ABANDONMENT WORKS.
 - REFER TO BHC2030 FOR LINEAR DRAINAGE NETWORK DETAILS.
 - REFER TO BHC3000 SERIES DRAWINGS FOR BELOW SLAB DRAINAGE.
 - LANDSCAPE DRAINAGE BY OTHERS.
 - PROPOSED DRAINAGE CONNECTIONS AWAITING CONFIRMATION FROM MASTERPLAN AND UNITED UTILITIES APPROVAL.
 - POSITION OF DRAINAGE LINES AND MANHOLES TO BE CONFIRMED WITH LANDSCAPE ARCHITECT.
 - "MERSEY ESTUARY POLLUTION ALLEVIATION SCHEME" (MEPAS).
WARNING: MEPAS TWIN 2700mm SEWERS LOCATED AS SHOWN. CONTRACTOR IS TO FAMILIARISE HIMSELF WITH SEWER LOCATION AND ASSOCIATED CONTROL EQUIPMENT. ALL WORK WITHIN IMMEDIATE VICINITY TO BE DISCUSSED WITH UNITED UTILITIES AND APPROVED PRIOR TO COMMENCEMENT.

- LEGEND
- PROPOSED EXTERNAL MANHOLE
 - SV → SV PROPOSED SURFACE WATER
 - FW → FW PROPOSED FOUL WATER
 - — — — — EXISTING FOUL RISING MAIN
 - ▲ BUILDING DISCHARGE POINT (REFER TO BHC3000 SERIES)
 - INDICATIVE LANDSCAPE DRAINAGE CATCHPIT (INCOMING LANDSCAPE DRAINAGE BY OTHERS)
 - LINEAR DRAINAGE SUMP
 - - - - - LINEAR DRAINAGE (REFER TO BHC 2030)
 - - - - - PERFORATED DRAIN FROM RETAINING WALLS
 - CONNECTION TO SEWERS

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01 TENDER ISSUE	12.05.05	RMAB
00 ORIGINAL ISSUE	04.04.05	RMAB

FOR TENDER	JUNE 05
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Architect: WILKINSONEY ARCHITECTS

Project: KINGS WATERFRONT
PROPOSED DRAINAGE
GENERAL LAYOUT AND KEY PLAN

Buro Happold
Consulting Engineers

Scale: 1:500 @ A1	Job No. 008636
Drawn by: ASK	Drawing No. BHC2000
Checked by: RMAB	Date: JUN 2005
Date: JUN 2005	Rev: 02

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3. REFER TO DRG BHC2020-21 FOR STANDARD DETAILS.
4. REFER TO MANHOLE SCHEDULE FOR MANHOLE AND INVERT LEVEL INFORMATION.
5. LANDSCAPE DRAINAGE BY OTHERS.

LEGEND

- PROPOSED EXTERNAL MANHOLE
- SV— PROPOSED SURFACE WATER
- FW— PROPOSED FOUL WATER
- — — — — EXISTING FOUL RISING MAIN
- ▲ BUILDING DISCHARGE POINT (REFER TO BHC3000 SERIES)
- INDICATIVE LANDSCAPE DRAINAGE CATCHPIT (INCOMING LANDSCAPE DRAINAGE BY OTHERS)
- LINEAR DRAINAGE SUMP
- — — — — LINEAR DRAINAGE (REFER TO BHC 2030's SERIES)
- — — — — PERFORATED DRAIN FROM RETAINING WALLS
- ⌋ CONNECTION TO SEWERS

FOR CONTINUATION REFER DRG BCH2003

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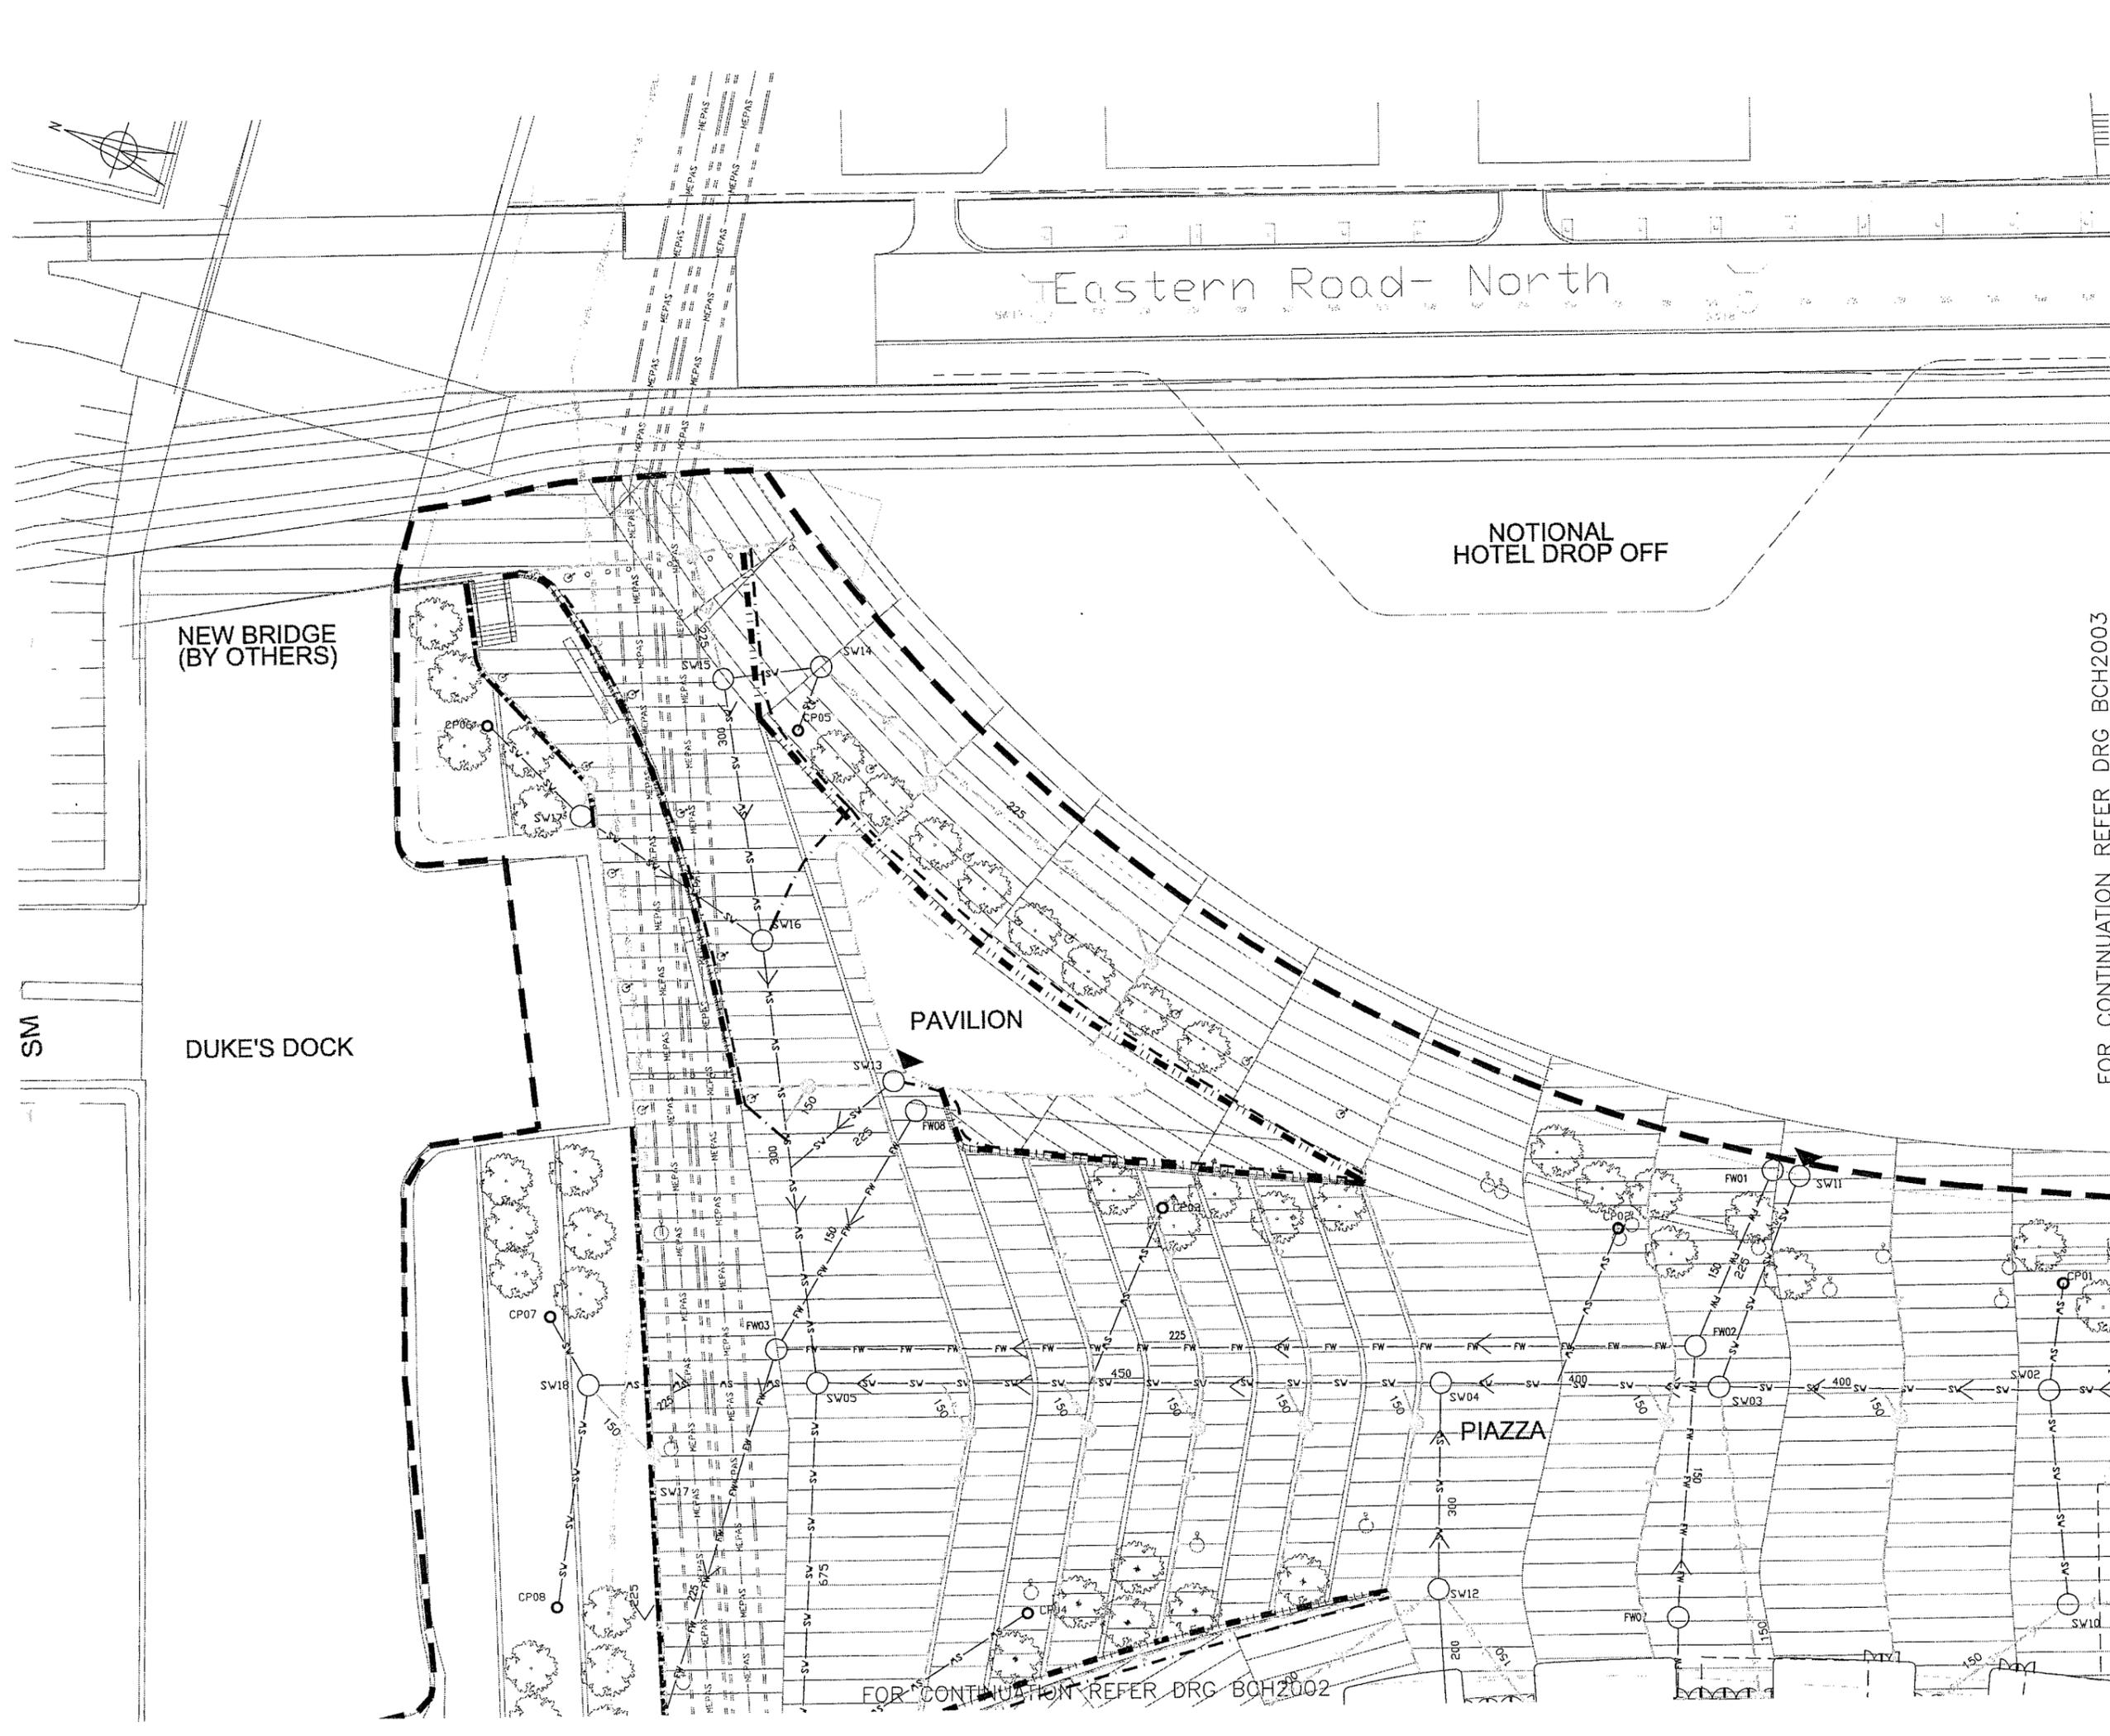
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Architect WILKINSONEY ARCHITECTS


Project **KINGS WATERFRONT
EXTERNAL DRAINAGE LAYOUT
SHEET 1 OF 4**

Scale 1:250 @ A1 Job No. **008636**
 Drawn by ASK Drawing No. **BHC2001**
 Checked by RMAB
 Date MAR 2005 Rev 02

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Consulting Engineers



FOR CONTINUATION REFER DRG BCH2002

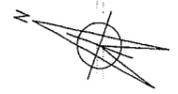

FOR CONTINUATION REFER DRG BCH2001

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 4. REFER TO MANHOLE SCHEDULE FOR MANHOLE AND INVERT LEVEL INFORMATION.
 5. LANDSCAPE DRAINAGE BY OTHERS.
 6. CONTRACTOR TO CONFIRM EXACT LOCATION OF RISING MAIN PRIOR TO START OF WORKS.

LEGEND

- PROPOSED EXTERNAL MANHOLE
- PROPOSED SURFACE WATER
- PROPOSED FOUL WATER
- EXISTING FOUL RISING MAIN
- BUILDING DISCHARGE POINT (REFER TO BHC3000 SERIES)
- INDICATIVE LANDSCAPE DRAINAGE CATCHPIT (INCOMING LANDSCAPE DRAINAGE BY OTHERS)
- LINEAR DRAINAGE SUMP
- LINEAR DRAINAGE (REFER TO BHC 2030's SERIES)
- PERFORATED DRAIN FROM RETAINING WALLS
- CONNECTION TO SEWERS

FOR CONTINUATION REFER DRG BCH2004

PROPOSED SEWERS IN THIS AREA ARE PROVISIONAL AND YET TO BE COORDINATED WITH RISING MAIN AND SOFT LANDSCAPING.

NEW MANHOLE TO BE CONSTRUCTED ON EXISTING FOUL SEWER AND EXISTING UPSTREAM CONNECTION ABANDONED.

MANHOLE EXTENDING TO CONCOURSE LEVEL

MANHOLE WITHIN ESCAPE PASSAGE

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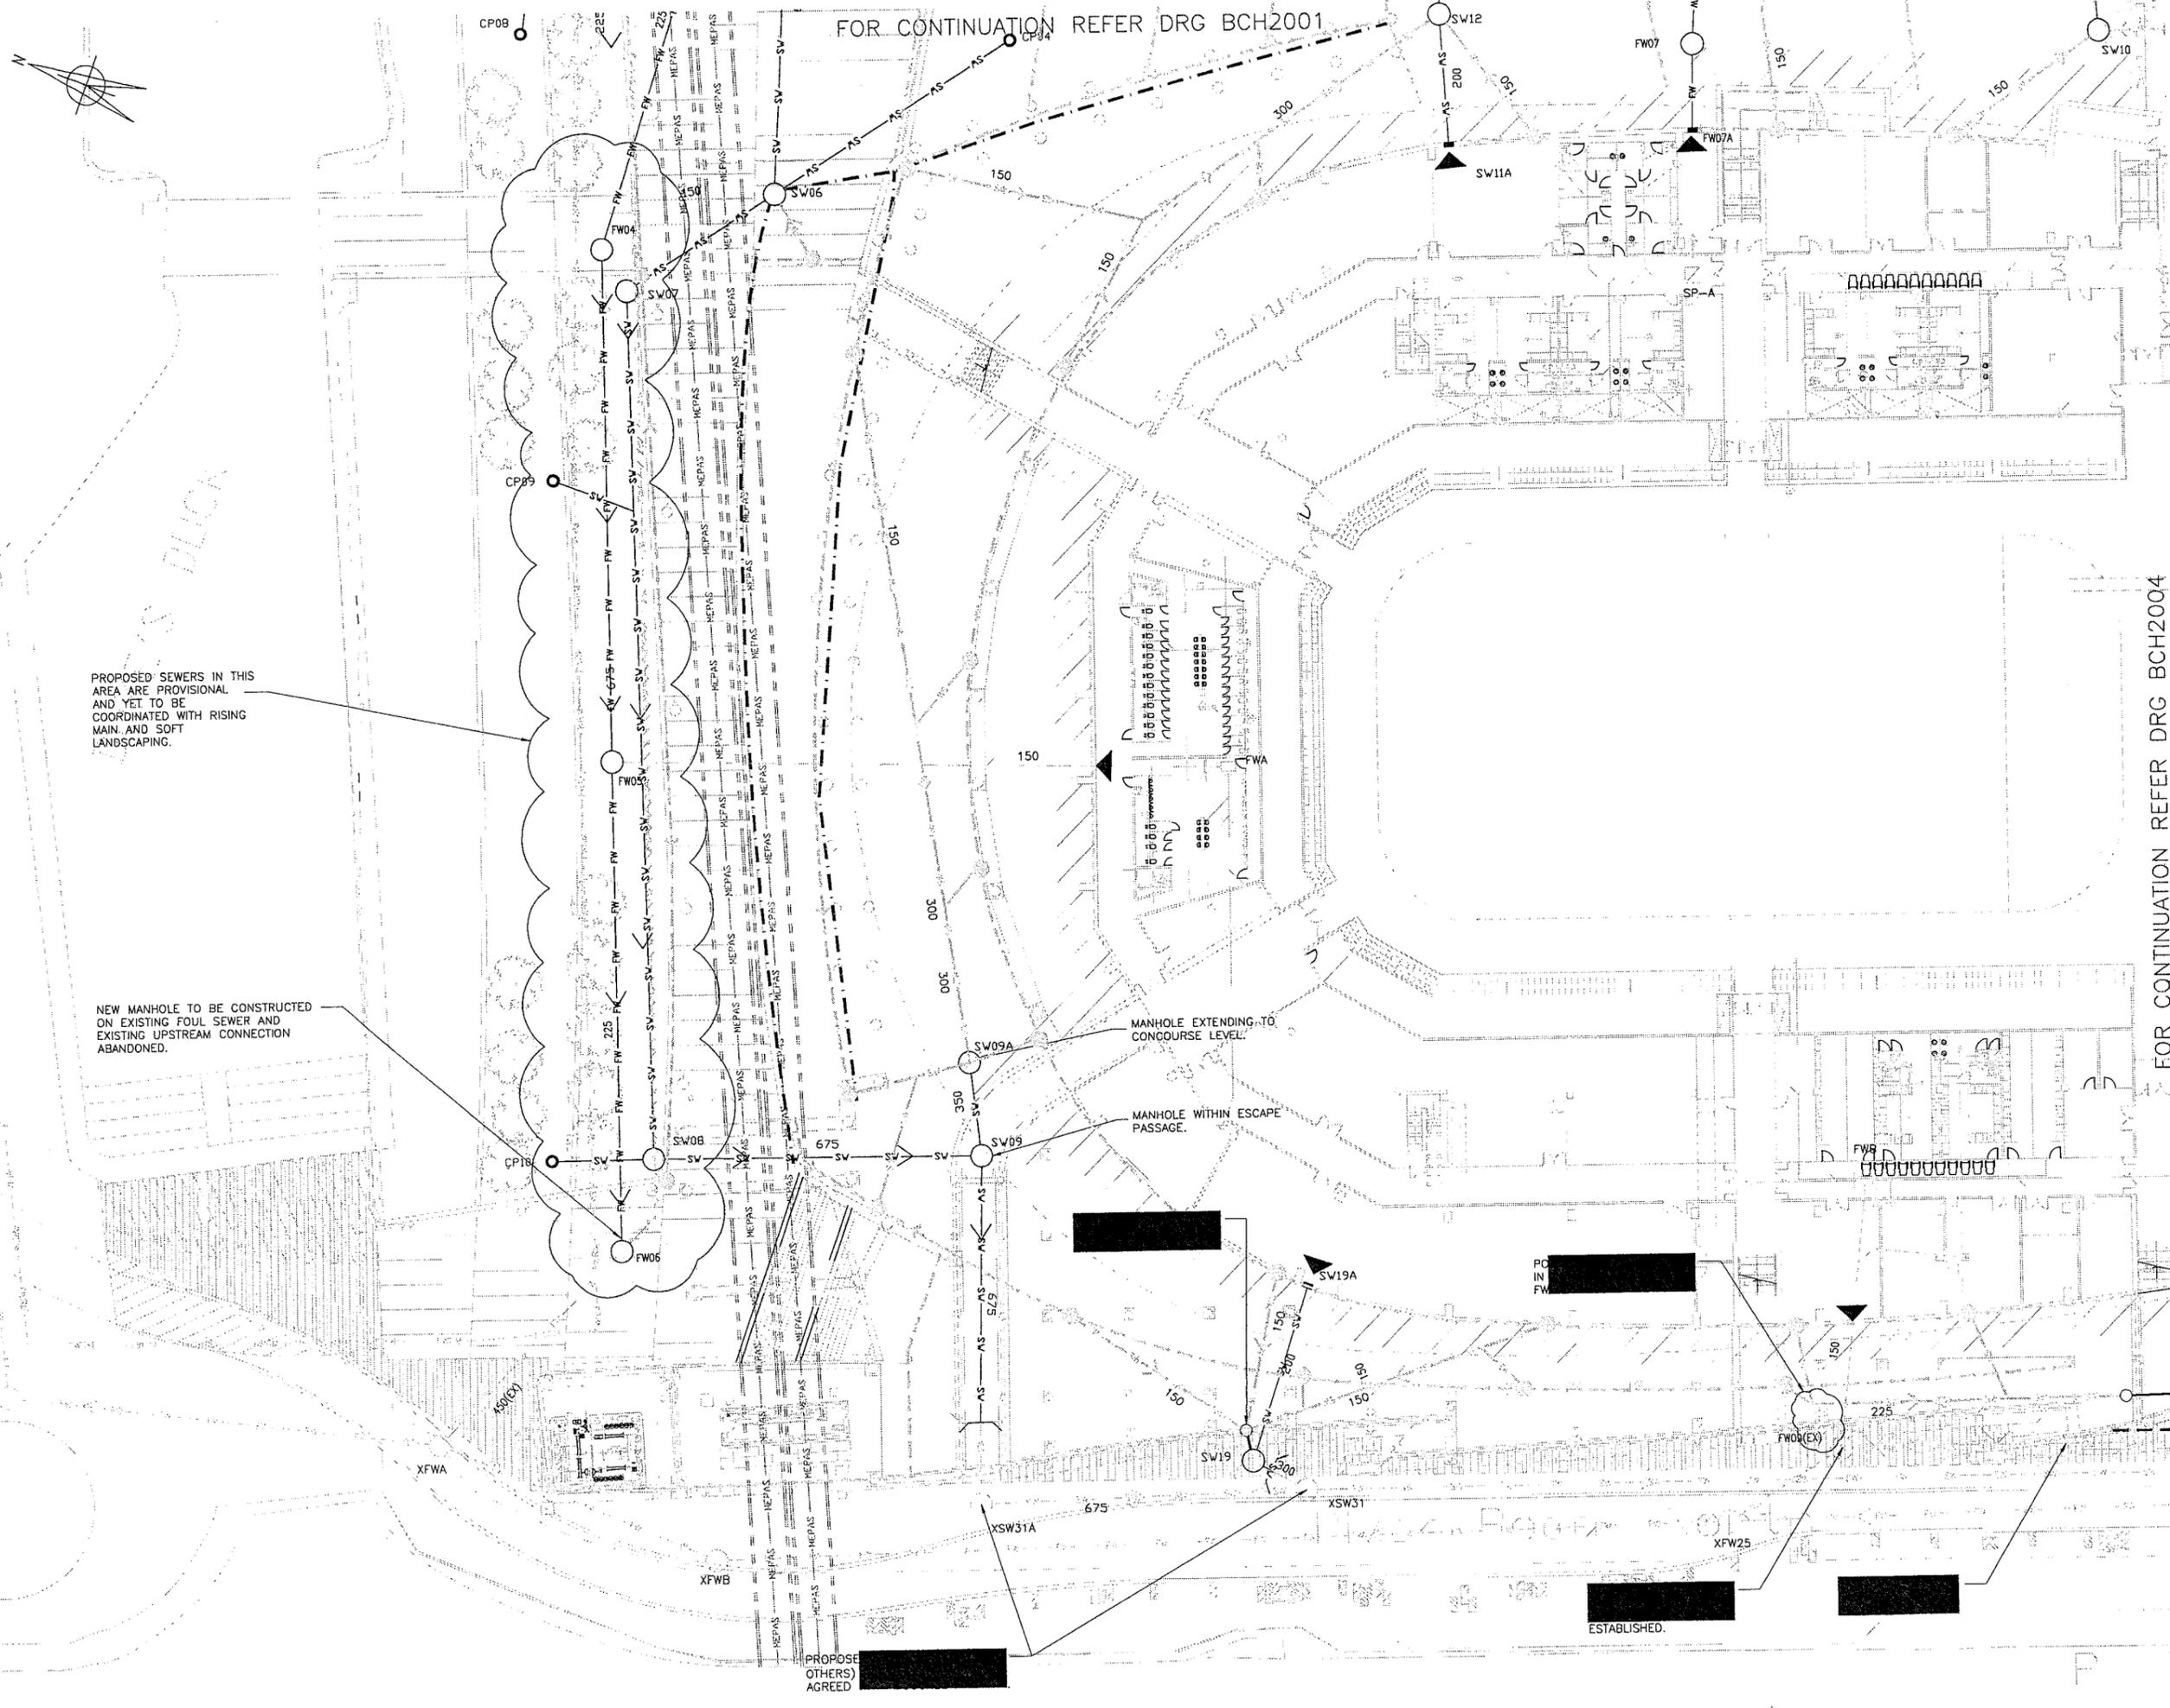
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Project: **KINGS WATERFRONT
EXTERNAL DRAINAGE LAYOUT
SHEET 2 OF 4**

Discs	1/250 @ A1	Job No.	008636
Drawn by	ASK	Drawing No.	BHC2002
Checked by	RMAB	Date	MAR 2005
Date	MAR 2005	Rev	02



PROPOSE (OTHERS) AGREED

ESTABLISHED.



Eastern Road - Centre

MULTI STOREY CARPARK

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 - REFER TO MANHOLE SCHEDULE FOR MANHOLE AND INVERT LEVEL INFORMATION.
 - LANDSCAPE DRAINAGE BY OTHERS.

LEGEND

- PROPOSED EXTERNAL MANHOLE
- PROPOSED SURFACE WATER
- PROPOSED FOUL WATER
- EXISTING FOUL RISING MAIN
- BUILDING DISCHARGE POINT (REFER TO BHC3000 SERIES)
- INDICATIVE LANDSCAPE DRAINAGE CATCHPIT (INCOMING LANDSCAPE DRAINAGE BY OTHERS)
- LINEAR DRAINAGE SUMP
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- PERFORATED DRAIN FROM RETAINING WALLS
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FOR CONTINUATION REFER DRG BCH2000

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Architect WILKINSONPERRY ARCHITECTS


Buro Happold
Consulting Engineer

Project **KINGS WATERFRONT
EXTERNAL DRAINAGE LAYOUT
SHEET 3 OF 4**

Scale	1:250 @ A1	Job No.	008636
Drawn by	ASK	Drawing No.	BHC2004
Checked by	RMB	Rev	02
Date	MAR 2005		

FOR CONTINUATION REFER DRG BCH2004

OR CONTINUATION REFER DRG BCH200

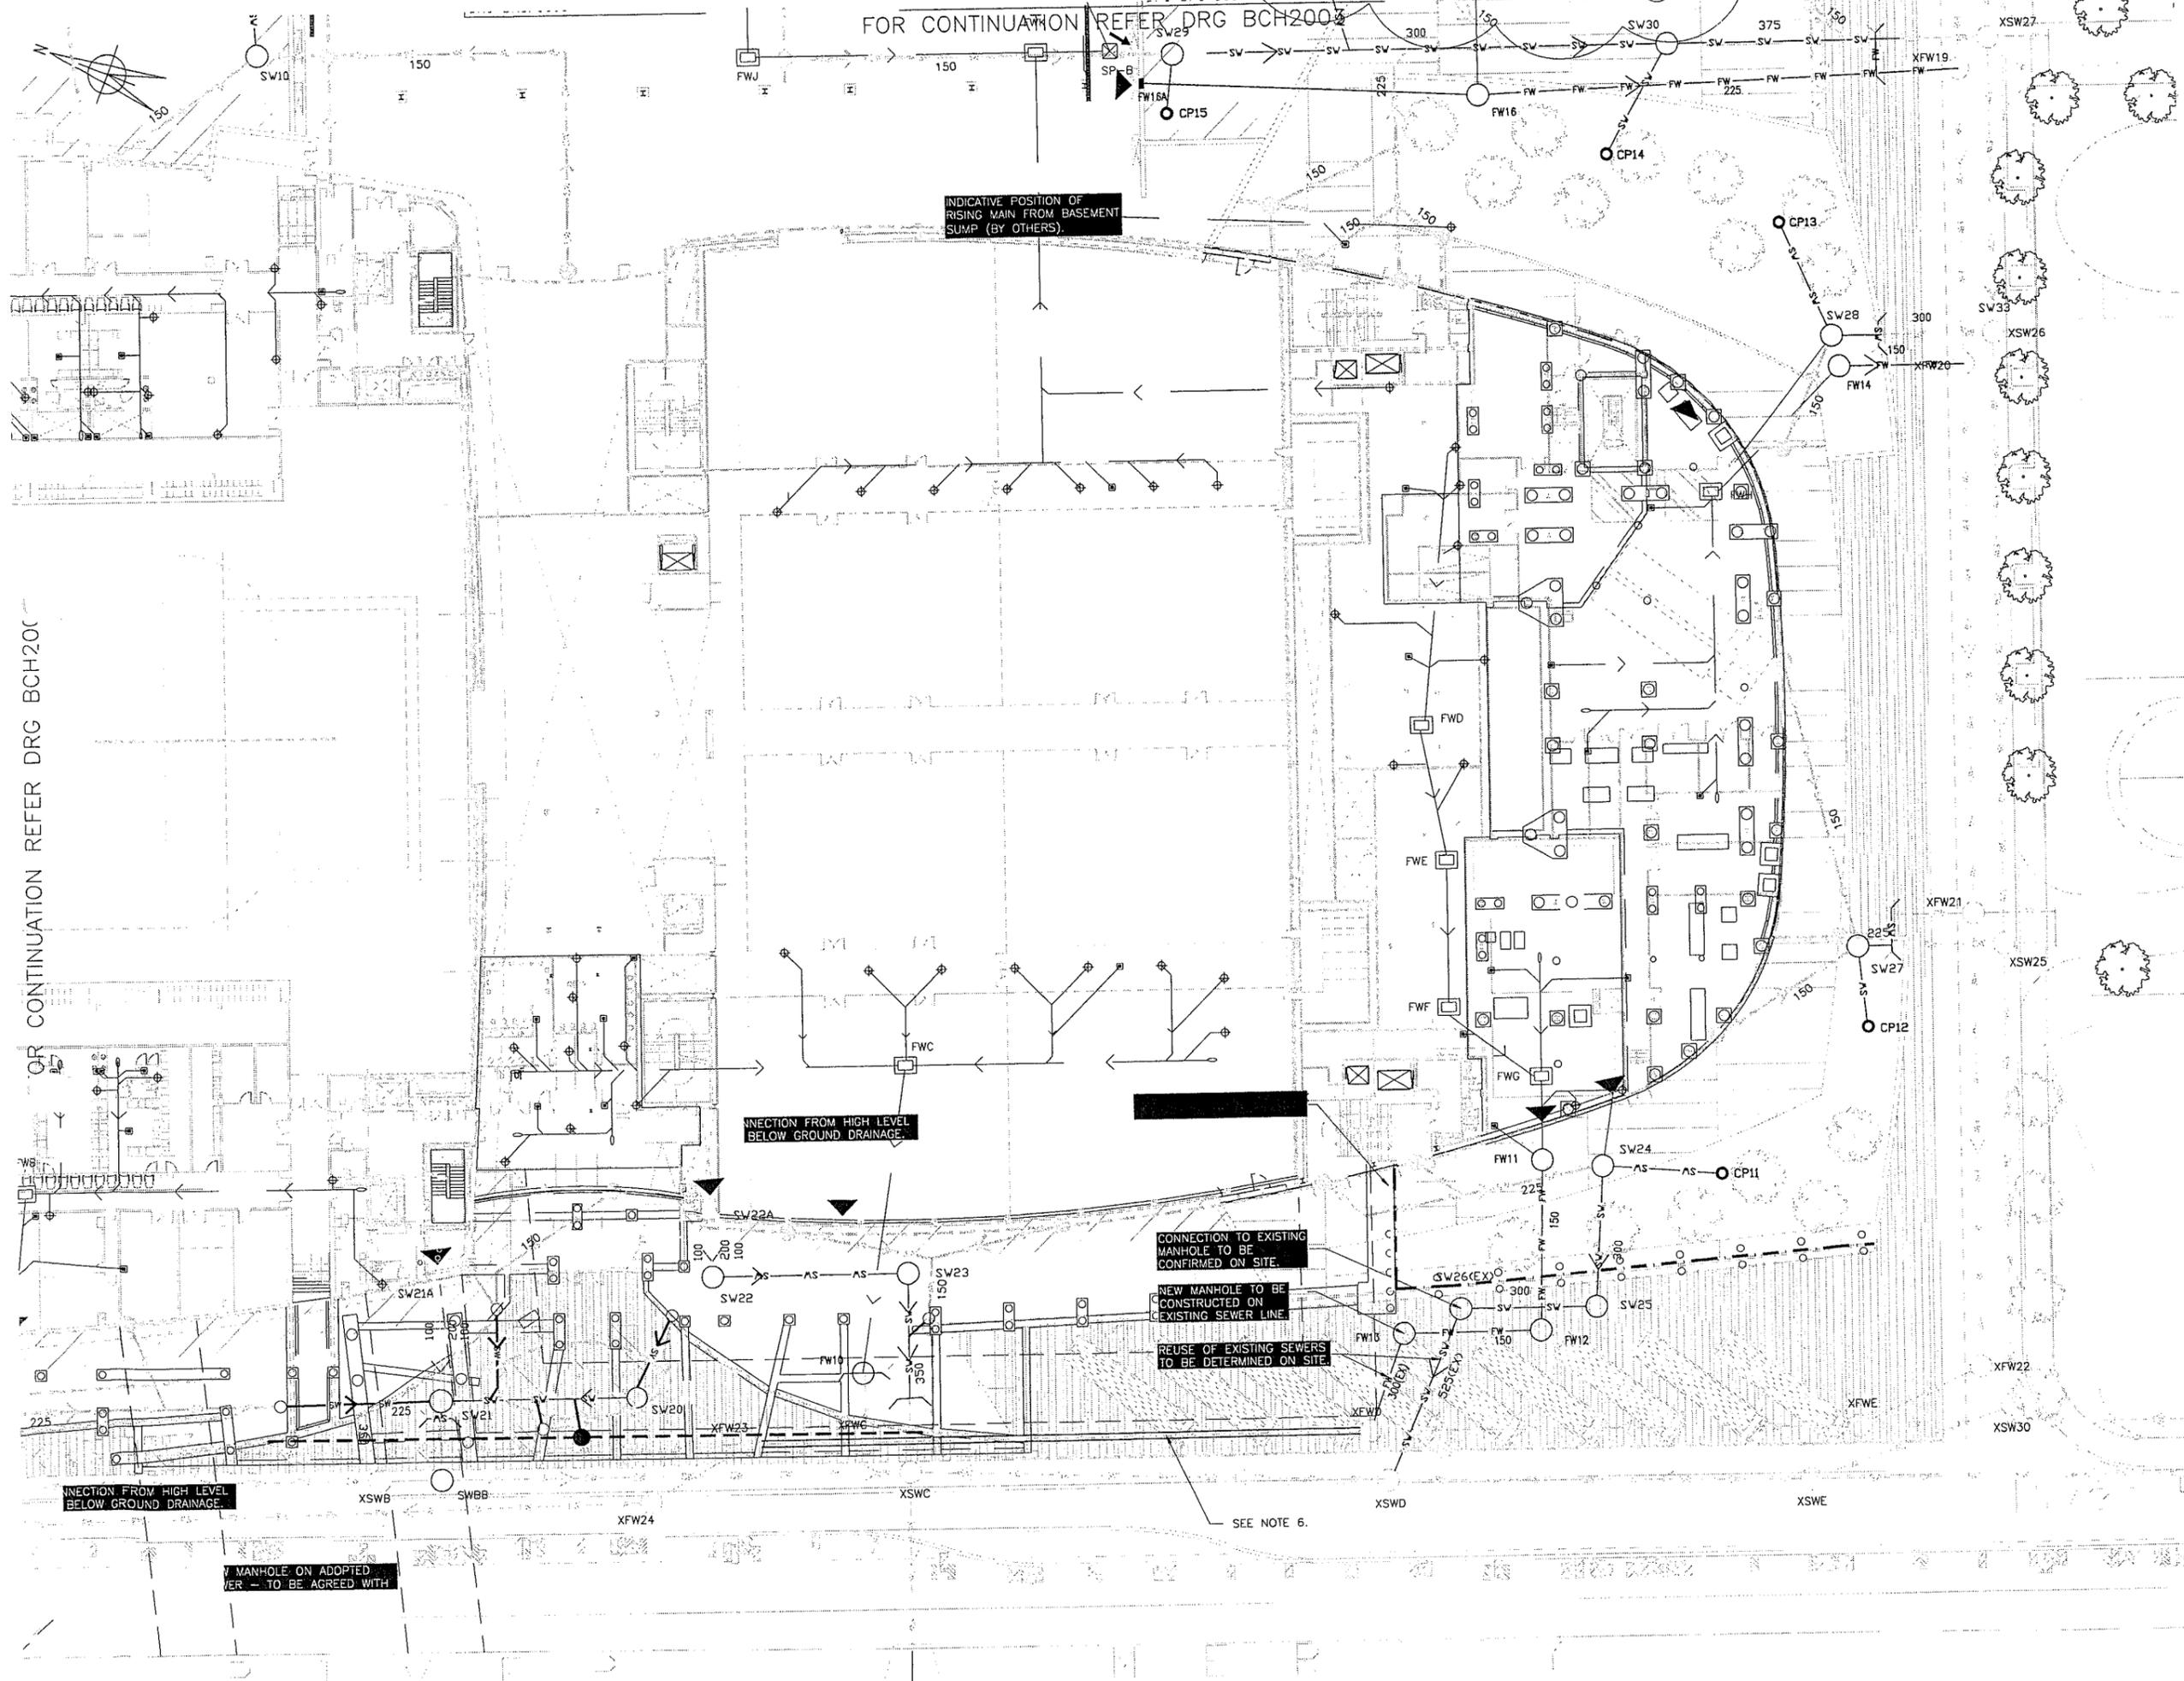

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 - LANDSCAPE DRAINAGE BY OTHERS.
 - CURED IN PLACE STRUCTURAL SEWER LINER TO BE INSTALLED WITHIN EXISTING FOUL SEWER WHERE SEWER PASSES BENEATH STRUCTURE. EXTENT AND DETAILS TO BE CONFIRMED.

- LEGEND
- PROPOSED EXTERNAL MANHOLE
 - sw → sw PROPOSED SURFACE WATER
 - fw → fw PROPOSED FOUL WATER
 - EXISTING FOUL RISING MAIN
 - ▲ BUILDING DISCHARGE POINT (REFER TO BHC3000 SERIES)
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Architect: WILKINSONEY ARCHITECTS

Project: **KINGS WATERFRONT
EXTERNAL DRAINAGE LAYOUT
SHEET 4 OF 4**

Scale:	1:250 @ A1	Job No.:	008636
Drawn by:	ASK	Drawing No.:	BHC2003
Checked by:	RMAB	Rev:	02
Date:	MAR 2005		